

FBF.1
S.P. 100 TO S.P. 404



750PCT DBS-TVf-RPF

All 1A

A2436



SP	150.00
0.00	2800
0.25	2700
0.50	2600
1.00	2500
1.50	2400
2.00	2300
2.50	2200
3.00	2100
3.50	2000
4.00	1900
4.50	1800
5.00	1700

SP	206.50	SP	216.50
0.00	2800	0.00	2800
0.25	2700	0.25	2600
0.50	2600	0.50	2500
1.00	2500	1.00	2400
1.50	2400	1.50	2300
2.00	2300	2.00	2200
2.50	2200	2.50	2100
3.00	2100	3.00	2000
3.50	2000	3.50	1900
4.00	1900	4.00	1800
4.50	1800	4.50	1700
5.00	1700	5.00	1600


SP	258.50
0.00	2800
0.25	2700
0.50	2600
1.00	2500
1.50	2400
2.00	2300
2.50	2200
3.00	2100
3.50	2000
4.00	1900
4.50	1800
5.00	1700

SP	297.00
0.00	2800
0.25	2700
0.50	2600
1.00	2500
1.50	2400
2.00	2300
2.50	2200
3.00	2100
3.50	2000
4.00	1900
4.50	1800
5.00	1700

SP	339.00
0.00	2800
0.25	2700
0.50	2600
1.00	2500
1.50	2400
2.00	2300
2.50	2200
3.00	2100
3.50	2000
4.00	1900
4.50	1800
5.00	1700

SP	366.00
0.00	2800
0.25	2700
0.50	2600
1.00	2500
1.50	2400
2.00	2300
2.50	2200
3.00	2100
3.50	2000
4.00	1900
4.50	1800
5.00	1700

SP	401.00
0.00	2800
0.25	2700
0.50	2600
1.00	2500
1.50	2400
2.00	2300
2.50	2200
3.00	2100
3.50	2000
4.00	1900
4.50	1800
5.00	1700

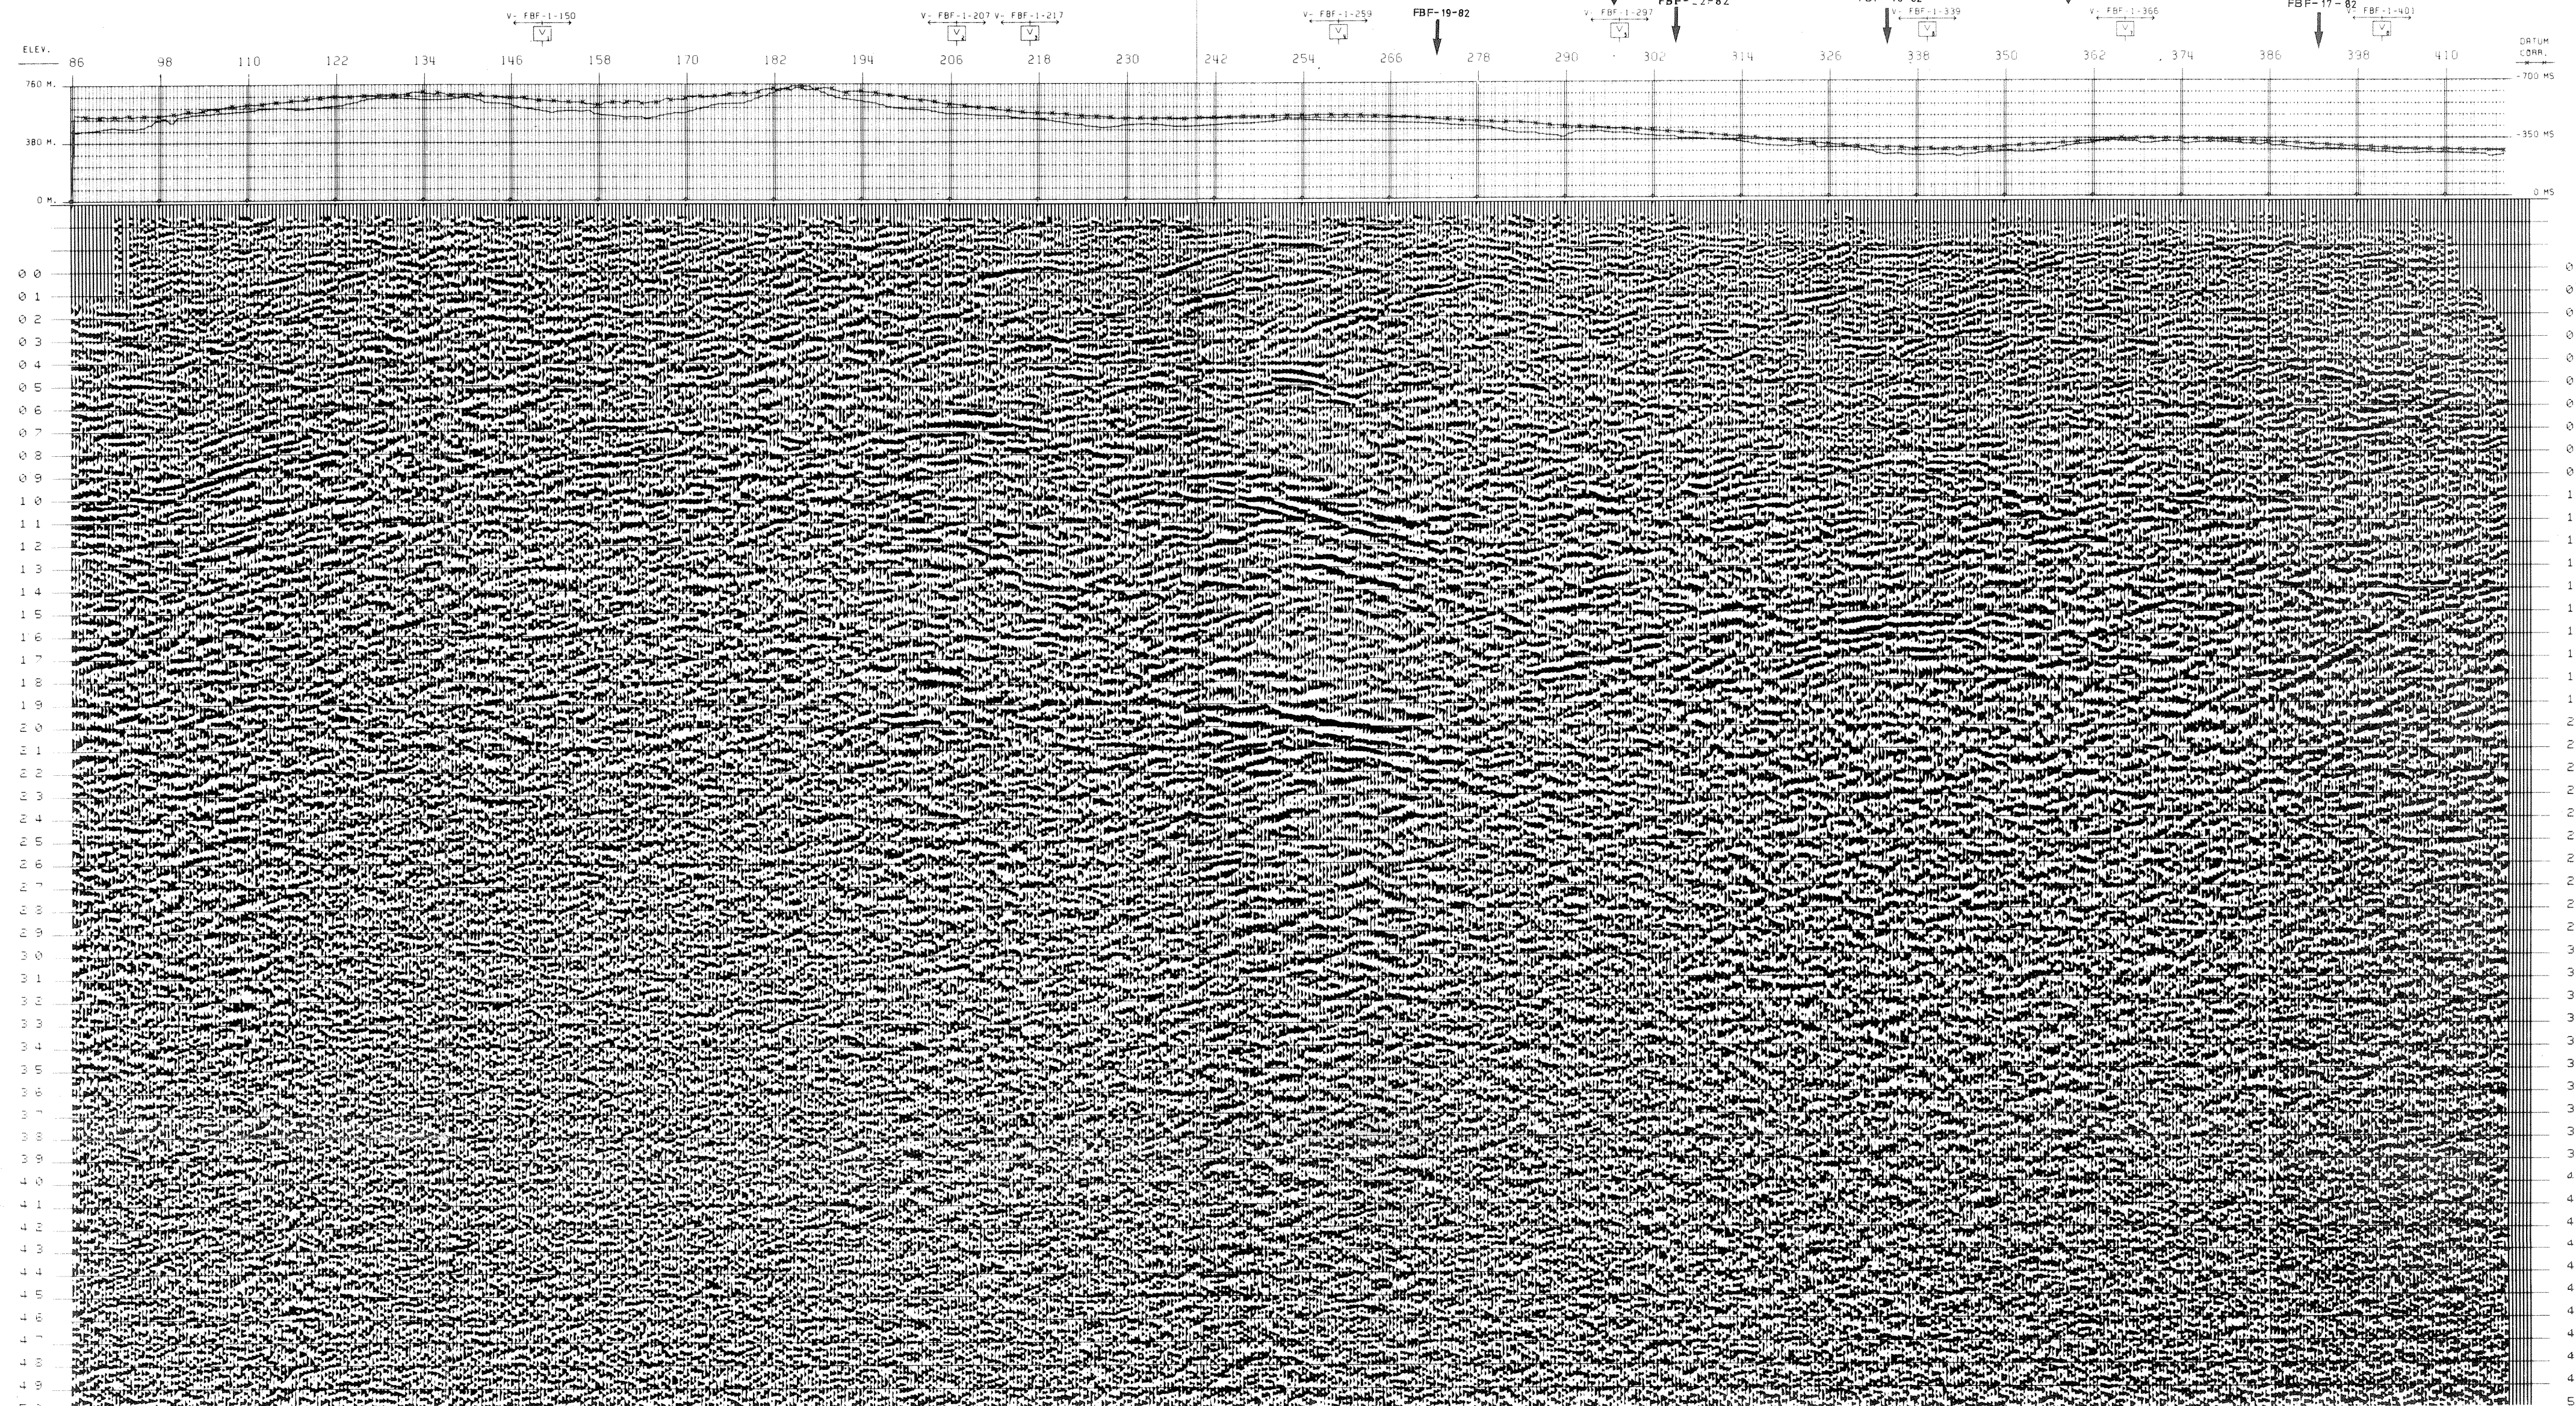

SNIA
WESTERN
RICERCHÉ GEOFISICHE

AREA FIUME BIFERNO

DATE SHOT: OCTOBER 1980
DATE PROCESSED: JUNE 1981

RECORDING DATA

RECORD NUMBER: 0155
RECORDING FILTER (HZ): 12/18/24/32
RECORD LENGTH: 90S
SAMPLE RATE (MS): 50
SUBSURFACE COVERAGE: 150 M
GROUP INTERVAL (METERS): 50
NUMBER OF GROUPS: 600
WEATHERING VELOCITY: 500 M/S
STATIC CORRECTION VELOCITY: 2000 M/S
DATA PLANE ABOVE SEA LEVEL: 0

PROCESSING SEQUENCE

GEOMETRICAL SPREADING CORIN
SHEARWAVE CORRECTION
DECONVOLUTION MINIMUM PHASE INVERSE FILTER
W/ AMPL. GAIN 100% MAX. PHASE DIST. 180MS
W/ 4 STATION 750PCT
SURFACE CONSISTENT RESID. STATICS
VELOCITY ANALYSIS
WMS STATICS W/VE APPLICATION
STRETCH DEPENDENT WAVE 100PCT
COR CONSISTENT RESIDUAL STATICS
STACK "SOPT" 106.99
LINE VARIATION FILTER
VERTICAL INTERPOLATION
MULTICHANNEL PASS
WMS GAIN
PULSE SHAPING
HORIZONTAL SCALE 8.20MS
VERTICAL SCALE 10 CM/MS

LEGEND

VELOCITY ANALYSIS
INTERSECTIONS
ANALYST: DATE: 6.81

LINE LOCATION MAP

FIUME BIFERNO
SCALA 1:200 000